

PROPOSED GROUP HOME LOT 21.01
55,501 SF
1.27 AC.

PROPOSED LOT 15.02
2,386,150 SF
54.78 AC.

PROPOSED LOT 15.03
(TO BE DEDICATED TO THE TOWNSHIP OF WEST WINDSOR)
10,211 AC
443,913 SF
WEST WINDSOR

IN ACCORDANCE WITH STATE AND MUNICIPAL REQUIREMENTS, AND FOLLOWING THEIR RESPECTIVE APPROVALS, THE WETLANDS AND AVERAGED TRANSITION AREA WILL BE DEDICATED TO THE STATE AND TOWN AS AN OPEN SPACE / CONSERVATION EASEMENT/PRESERVED FARMLAND.

WETLANDS AREA TO BE SEEDED WITH AN APPROPRIATE MIX OR MAY REMAIN AS ACTIVE FARMLAND.

PROPOSED WET POND WITH AERATOR AND LINER. SEE DETAILS. BASIN BOTTOM 88.00 PERMANENT POOL 92.00 100 YEAR WSE 98.03.

Heritag at West Windsor - Unit Type & Quantity Breakdown	Building Type	Unit Type	Total Buildings	Total Units
Type A	4 Townhouse Units	7	28 Units	
Type B	5 Townhouse Units	3	15 units	
Type C	6 Townhouse Units	7	42 Units	
Type D	4 Townhouse Units	11	44 Units	
Type E	4 Affordable Units	15	60 Units	
Type F	5 Townhouse Units	1	5 units	
Total		44	254	

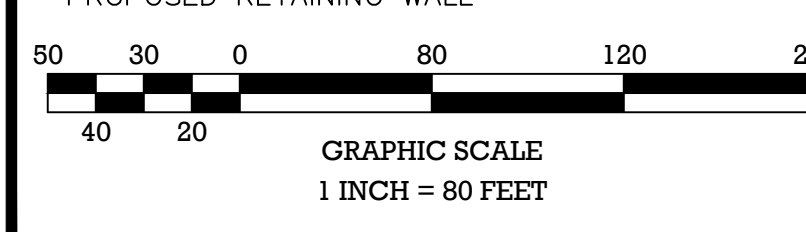
UNIT TYPE (R/SIS)	UNITS	SPACES REQUIRED	SPACES PROPOSED
TOWNHOUSE (GARAGE & DRIVEWAY) ¹ 3-BEDROOM UNIT (2.4 SPACES / UNIT)	194	466	485
TOWNHOUSE (GUEST PARKING) ² (0.5 SPACES / UNIT)		97	97 ³
SUB-TOTAL	194	563	582 ³
GARDEN APARTMENT 1-BEDROOM UNIT (1.8 SPACES / UNIT)	12	22	22
2-BEDROOM UNIT (2.0 SPACES / UNIT)	36	72	72
3-BEDROOM UNIT (2.1 SPACES / UNIT)	12	25	25
GROUP HOME 4-BEDROOM UNIT (2.5 SPACES / UNIT)	1	3	9
SUB-TOTAL	61	122	128
TOTAL	255	685	710 ³

1. A MINIMUM OF 7 HANDICAP PARKING STALLS ARE REQUIRED AND 8 ARE PROVIDED.
2. THE PROJECT PROPOSES 255 UNITS, 64 (25.1%) OF WHICH ARE AFFORDABLE.
3. PER R.S.I.S. (N.J.A.C. 5.21-4.14(d)3.) A 2-CAR GARAGE & DRIVEWAY COMBINATION WITH A MINIMUM 20 FT WIDE DRIVEWAY SHALL COUNT AS 3.5 OFF-STREET SPACES PER UNIT. AS THE PROJECT DRIVEWAYS HAVE BEEN DESIGNED AT 18 FT WIDE, THIS STANDARD HAS BEEN CONSERVATIVELY REDUCED TO 2.5 OFF-STREET SPACES PER UNIT.
4. PER R.S.I.S. TABLE 4.4, NOTE B
5. 23 SPACES PROPOSED AS LAND BANKED PARKING.

PROJECT NAME: HERITAGE AT WEST WINDSOR		ZONE: R-SD: Residence District				
PROPOSED USE: Residential: Townhouses, Apartments and Group Home						
BLOCK 28, LOTS 15 & 21						
BULK ZONE CRITERIA						
MIN. TRACT AREA	\$200-186A(1)	5 Ac.	66.74 Ac.	66.26 Ac.	YES	
MIN. TRACT FRONTAGE	Edinburg Road (C.R. 535)	\$200-186A(2)	150 Ft.	336.11 Ft.	351.96 Ft.	YES
	Princeton Hightstown Rd (C.R. 571)	\$200-186A(2)	150 Ft.	351.69 Ft.	351.69 Ft.	YES
MIN. OPEN SPACE PRESERVATION	\$200-189.3B(3)	30 Ac.	N/A	30.7 Ac.	YES	
MIN. USABLE RECREATION FACILITIES AREA	\$200-189.3B(4)	2.5% Gross Tract (1.67 AC)	N/A	3.3 AC ¹	YES	
MIN. OPEN SPACE FOR ACTIVE RECREATION	\$200-189.3B(6)	2 AC	N/A	3.3 AC ¹	YES	
AVERAGE GROSS DENSITY	\$200-189C	10 DU / Ac.	N/A	3.8 DU/Ac ²	YES	
NET DENSITY	\$200-189.3A(5)(a)	25 DU/Ac.	N/A	9.8 DU/Ac ³	YES	
MAX. IMPROVEMENT COVERAGE	\$200-186A(5)	40%	1.4%	29.6%	YES	
MAX. BUILDING HEIGHT	\$200-186C	4 Story / 45 Ft.	N/A	< 4 Story / 45 Ft.	YES	
BUILDING SETBACKS						
Local Internal Road	\$200-190A (2)(h)(2)(a)	20 Ft.	N/A	20.1 Ft.	YES	
Edinburg Road (C.R. 535)	\$200-190A (2)(h)(2)(a)	50 Ft.	46.6 Ft.	60.2 Ft.	YES	
Princeton Hightstown Rd (C.R. 571) (Building 8)	\$200-190A (2)(h)(2)(a)	50 Ft.	N/A	61.8 Ft.	YES	
Princeton Hightstown Rd (C.R. 571) (Group Home)	\$200-190A (2)(h)(2)(a)	50 Ft.	N/A	50.9 Ft.	YES	
DESIGN STANDARDS						
Building Layout	\$200-30A					
End Wall to End Wall	\$200-30A	Min. 12 Ft.	N/A	30 Ft.	YES	
Building Face to Street Curb	\$200-30A	Min. 20 Ft.	N/A	20.1 Ft.	YES	
End Wall to Window Wall	\$200-30A	Min. 12 Ft.	N/A	12.4 Ft.	YES	
Window Wall to Window Wall	\$200-30A	Min. 30 Ft.	N/A	30 Ft.	YES	
Window Wall to Window Wall	\$200-189.3B(2)	Min. 30 Ft.	N/A	30 Ft.	YES	

LEGEND

- EXISTING BOUNDARY
- EXISTING CURB
- PROPOSED CURB
- EXISTING BUILDING
- PROPOSED BUILDING
- PROPOSED SIGN
- PROPOSED SETBACK
- EXISTING FENCELINE
- PROPOSED FENCELINE
- 100-YR WATER SURFACE ELEV.
- BASIN BOTTOM
- PROPOSED RETAINING WALL



EDINBURG ROAD (A.K.A. COUNTY ROUTE No. 535) (A.K.A. OLD TRENTON ROAD) (A.K.A. MERCERVILLE-EDINBURG ROAD) (VARIABLE WIDTH R.O.W.)

PROPOSED STRIPING IMPROVEMENTS TO CREATE A SHOULDER, CENTER TURN LANE AND THROUGH LANES SUBJECT TO THE APPROVAL OF MERCER COUNTY

NOTE: BUILDING PERIMETER FRONTAGE ALONG ROADWAYS IS 7,600 FT. THE TOTAL BUILDING PERIMETER IS 18,150 FT. RESULTING IN 42% OF THE BUILDING PERIMETER BEING FRONTAGE.

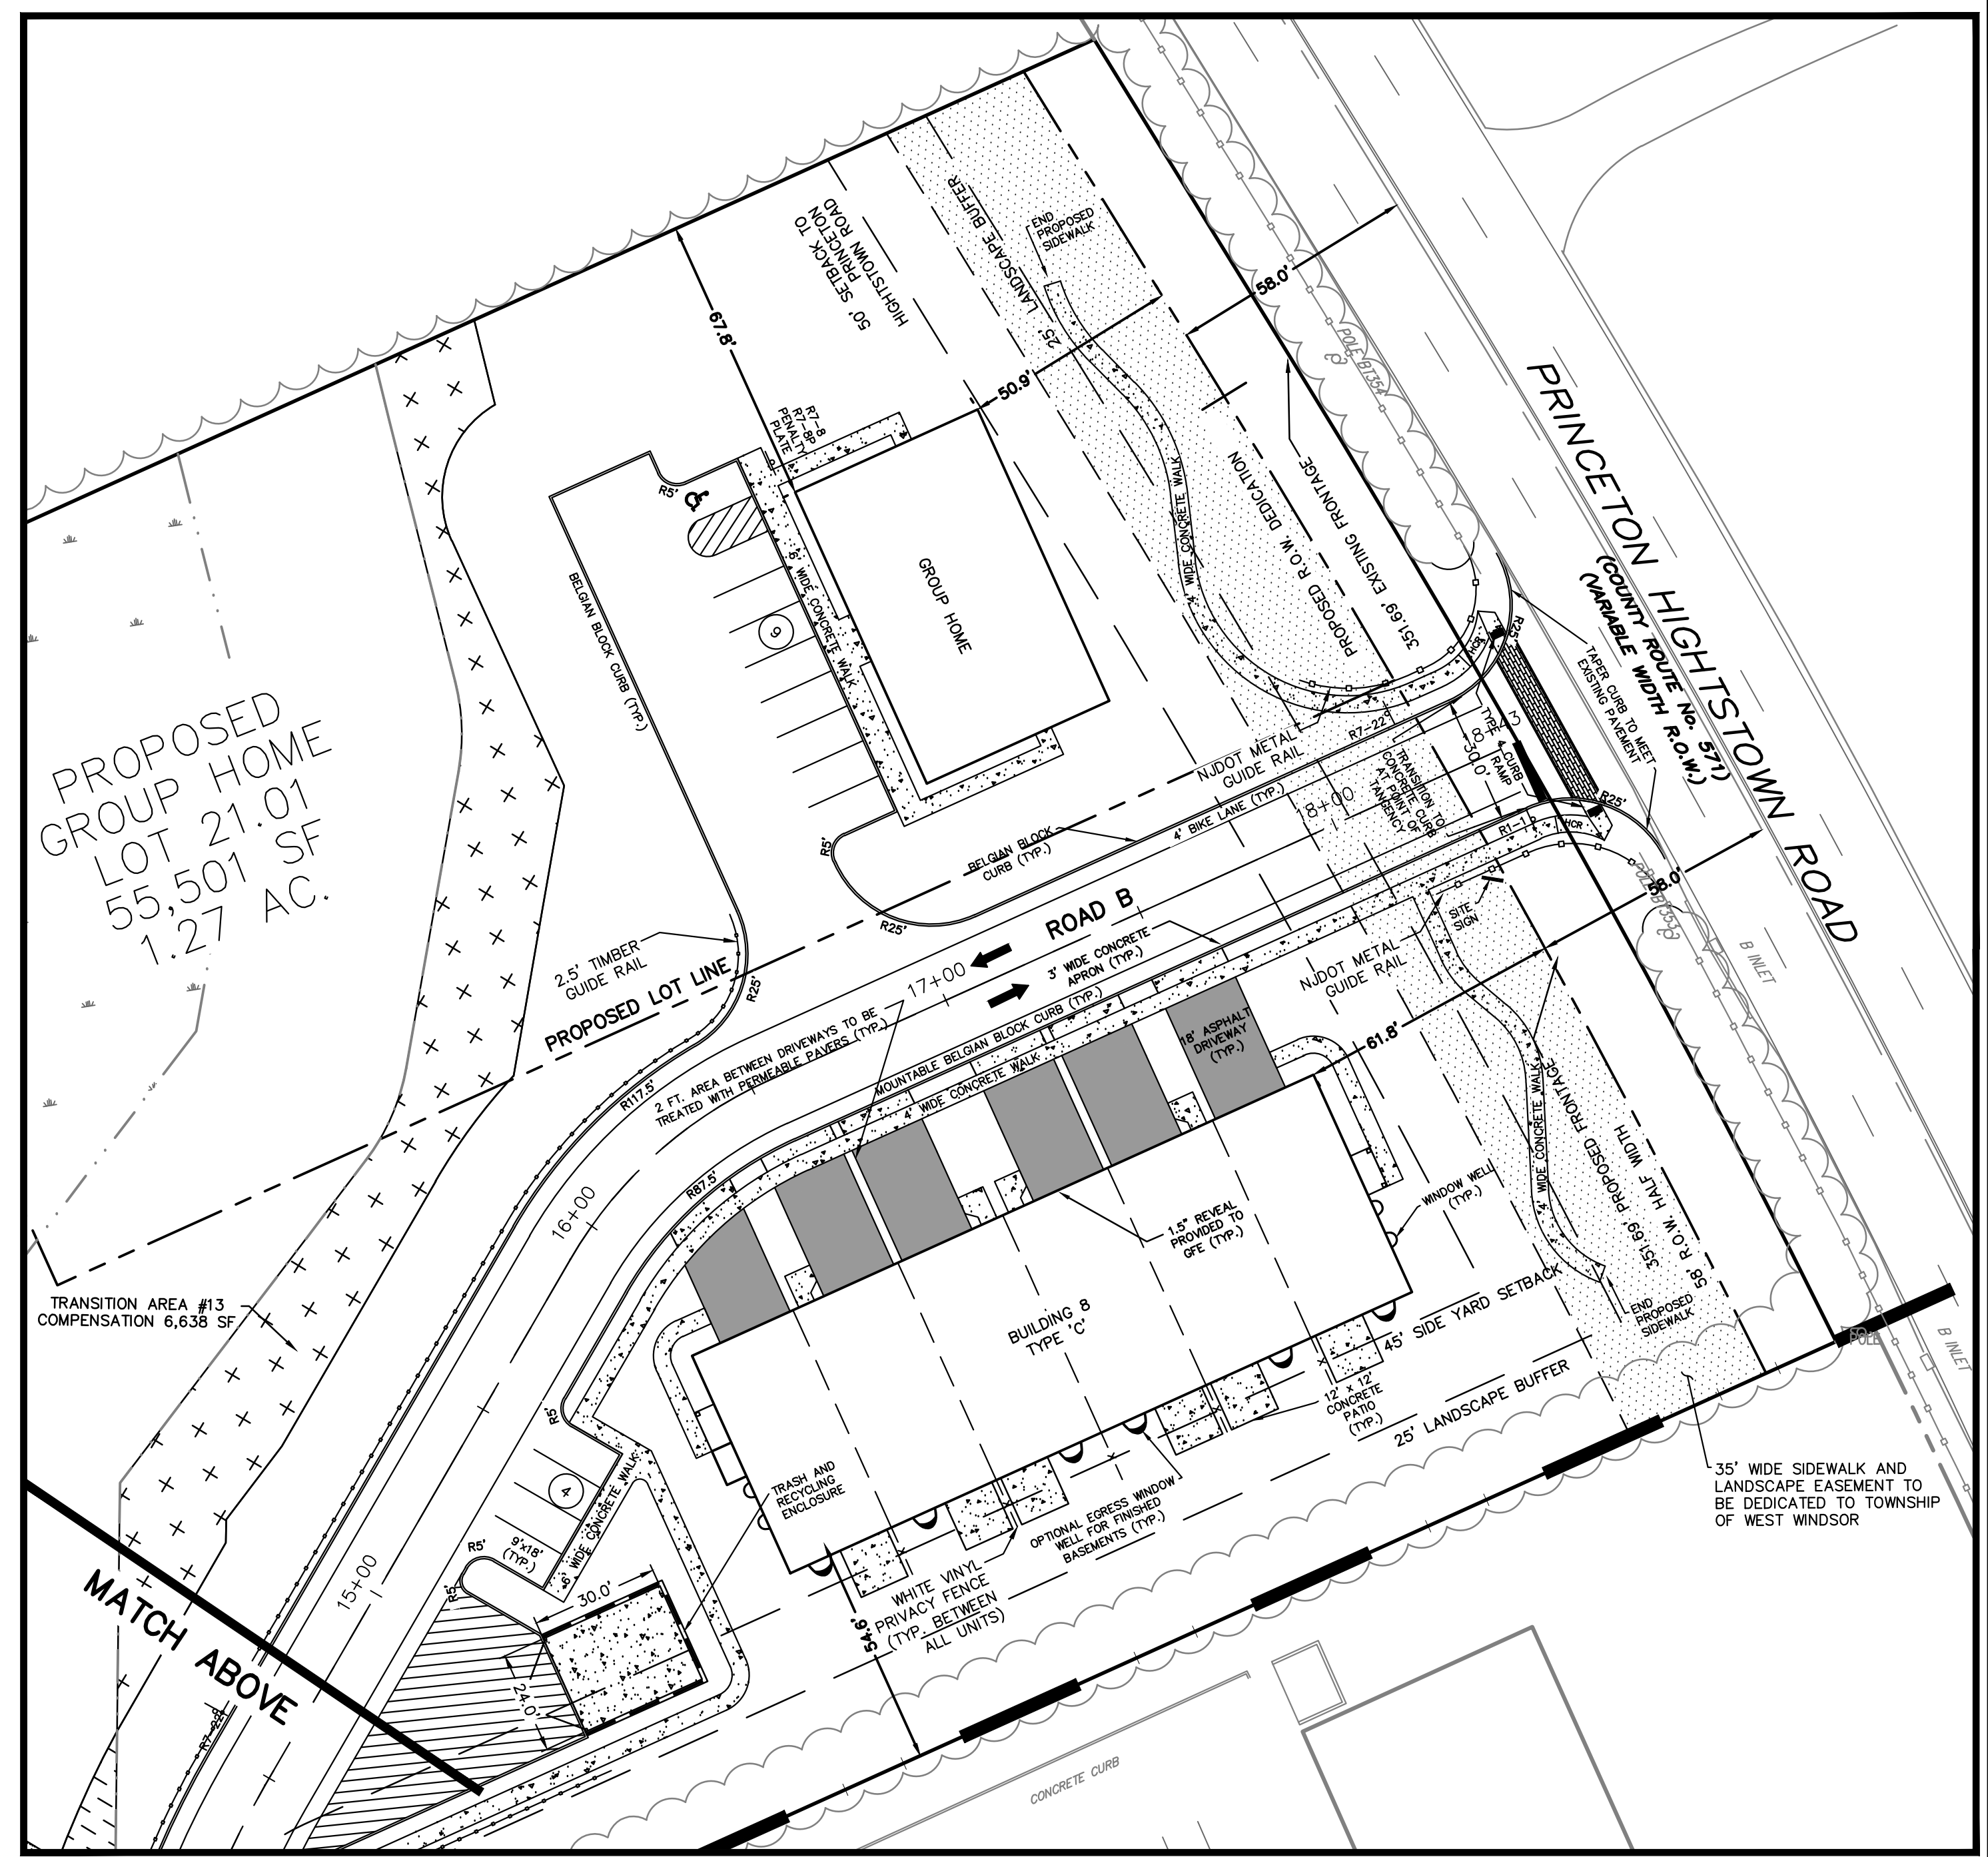
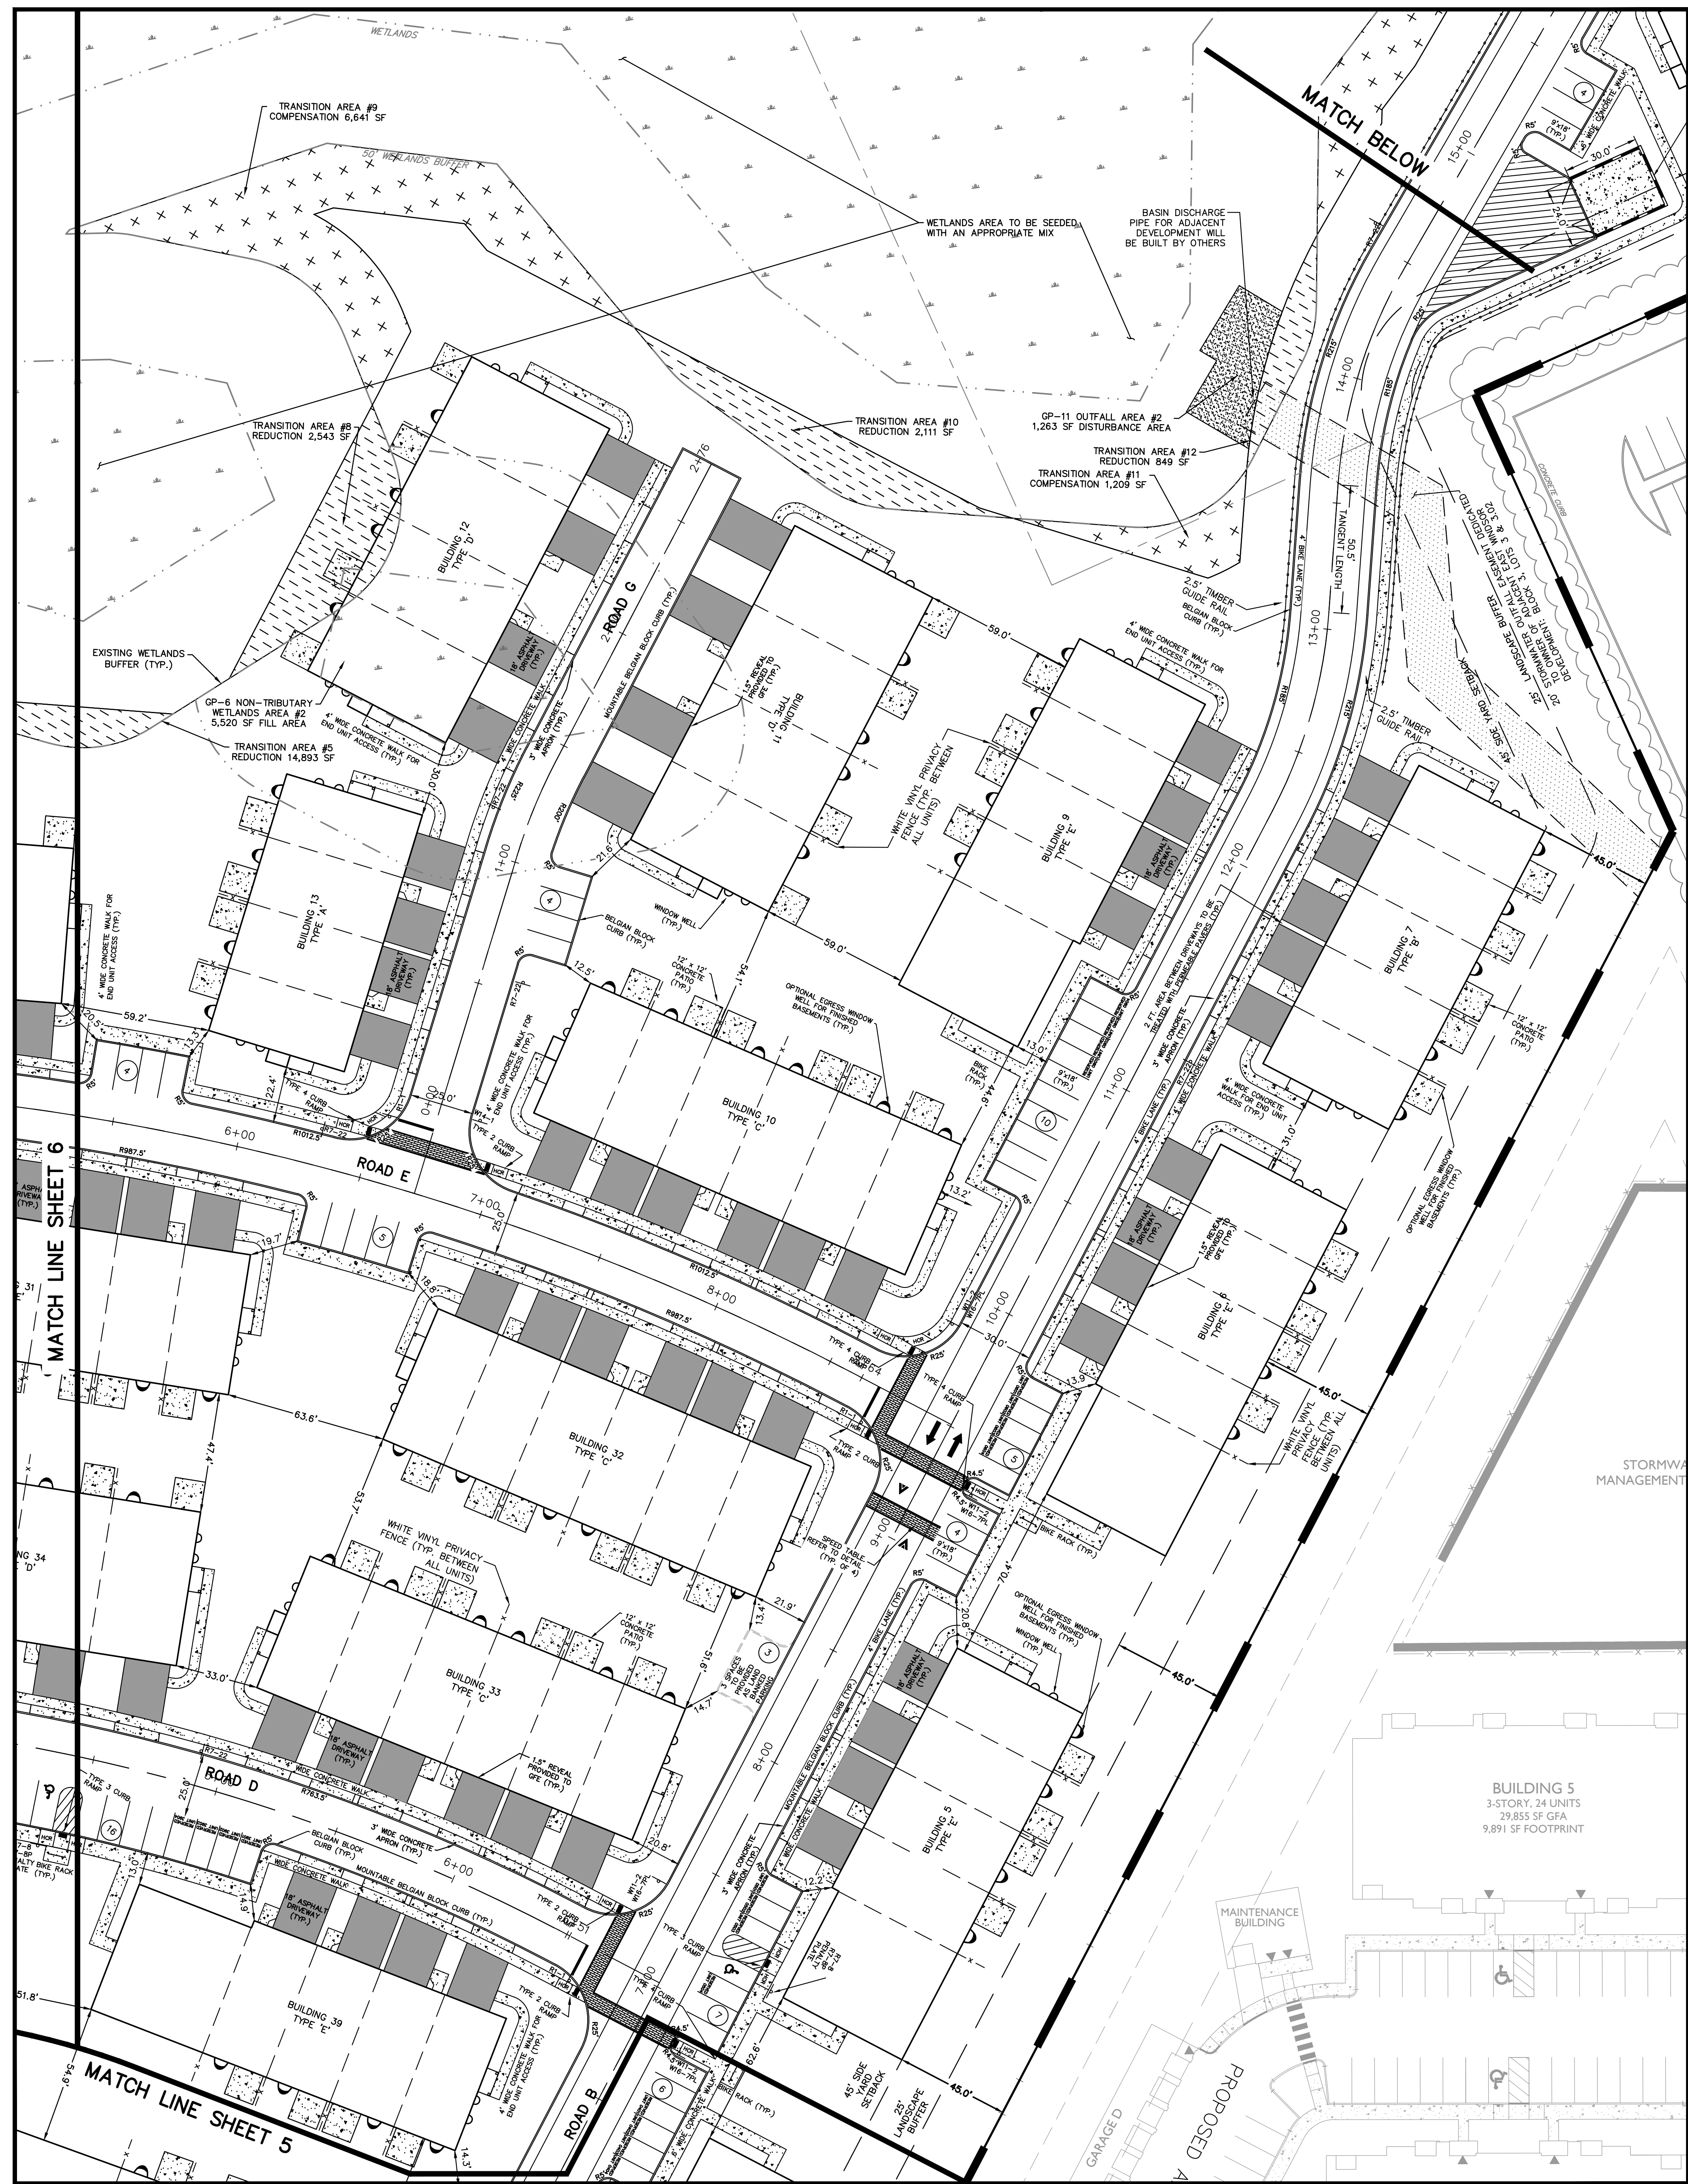
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CHECKED BY: MWW
DATE: 03/05/20
PROJECT No.: APP-184
DRAWING NAME: 03-LAYOUT.dwg

10/02/20
DATE
10/02/20
DATE

William J. Parkhill II, P.E.
PROFESSIONAL ENGINEER
No. 00000000000000000000

PRELIMINARY/FINAL MAJOR SITE PLAN & SUBDIVISION
BLOCK 28, LOTS 15 & 21
HERITAGE AT WEST WINDSOR
OVERALL GEOMETRY, SIGNAGE & STRIPEAGE PLAN
SITUATED IN
TOWNSHIP OF WEST WINDSOR, MERCER COUNTY, NEW JERSEY

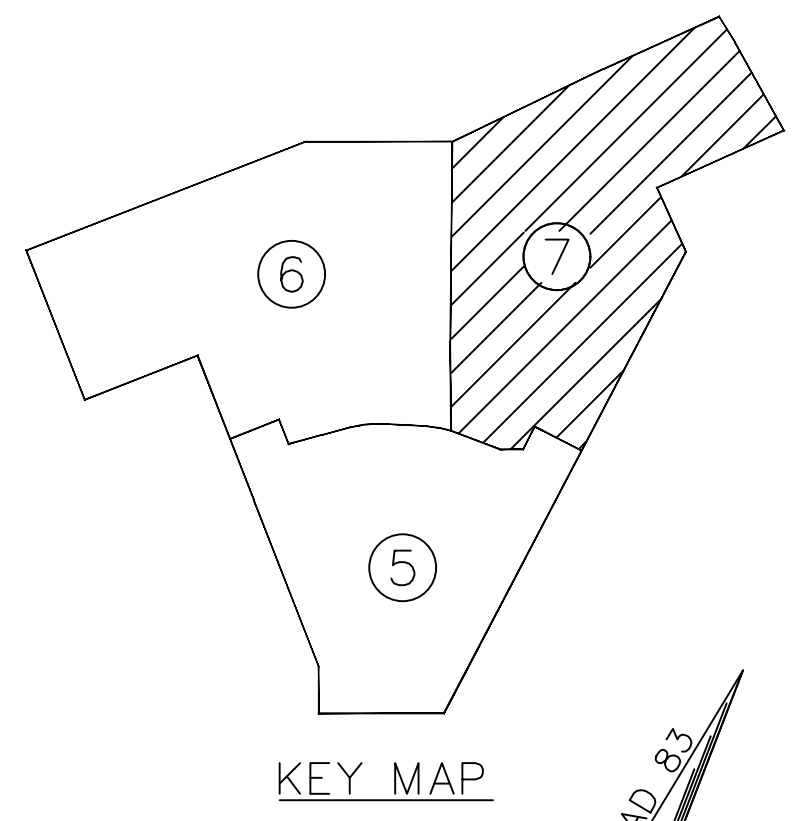
Sheet Number
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Wetlands Transition Areas	Reduction	Compensation
Area 1	1,748 SF	5,979 SF
Area 2	903 SF	2,632 SF
Area 3	14,893 SF	2,632 SF
Area 4	Removed	
Area 5	Removed	
Area 6	Removed	
Area 7	Removed	
Area 8	2,543 SF	6,641 SF
Area 9	2,111 SF	1,209 SF
Area 10	849 SF	6,638 SF
Area 11		
Area 12		
Area 13		
Total	23,047 SF	23,079 SF
Net Addition = +32 SF		

*Existing Group Home Transition Area = 148,470 SF

Wetlands General Permit Areas	Buffer	Wetlands
GP1 Area 1		16,852 SF
GP2 Area 2		5,520 SF
GP11 Area 1	1,110 SF	1,512 SF
GP11 Area 2		0 SF
Sub-Total	2,379 SF	23,884 SF
Total	26,257 SF	



LEGEND

- EXISTING BOUNDARY
- EXISTING CURB
- EXISTING BUILDING
- PROPOSED BUILDING
- PROPOSED SIGN
- PROPOSED SETBACK
- EXISTING FENCELINE
- PROPOSED FENCELINE
- 100-YR WATER SURFACE ELEV.
- BASIN BOTTOM
- PROPOSED RETAINING WALL

GRAPHIC SCALE
1 INCH = 30 FEET

PRELIMINARY/FINAL MAJOR SITE PLAN & SUBDIVISION
 BLOCK 28, LOTS 15 & 21
 HERITAGE AT WEST WINDSOR
 LAYOUT PLAN

SITUATED IN
 TOWNSHIP OF WEST WINDSOR, MERCER COUNTY, NEW JERSEY

10/02/20
 William J. Parkhill II, P.E.
 PROFESSIONAL ENGINEER
 No. 141,766, 06/09/2009

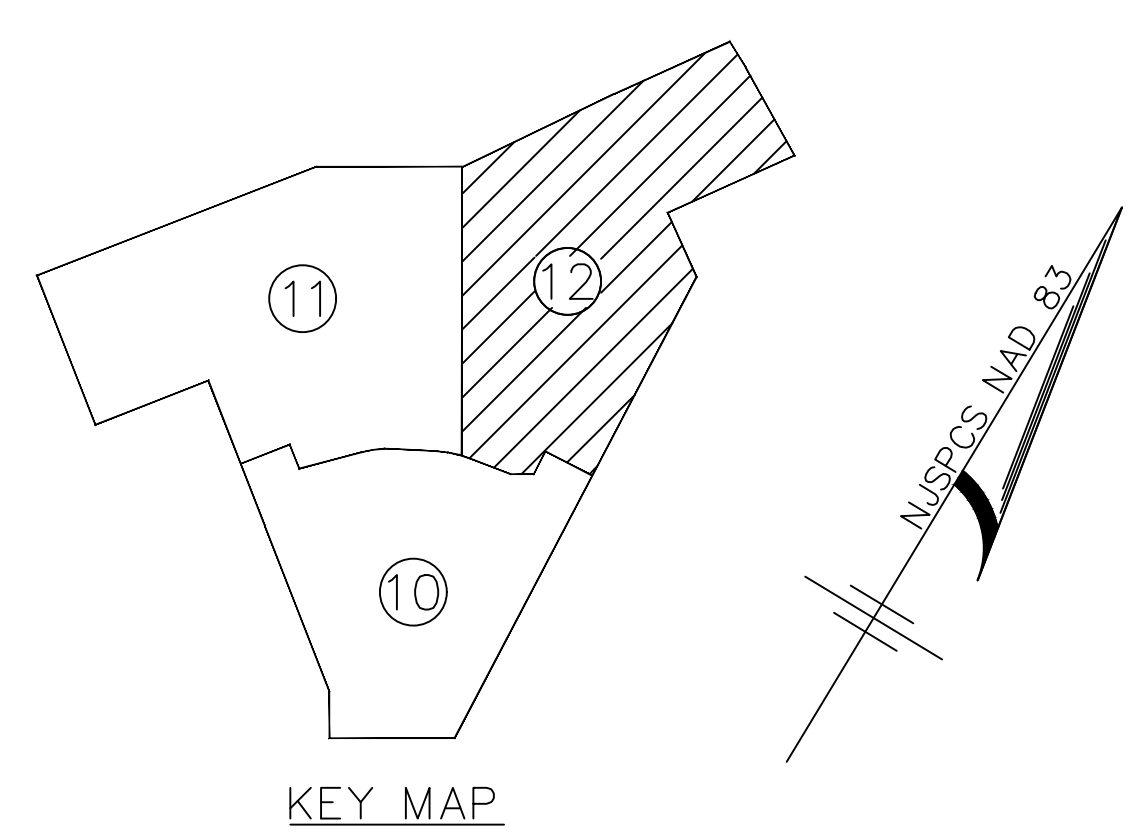
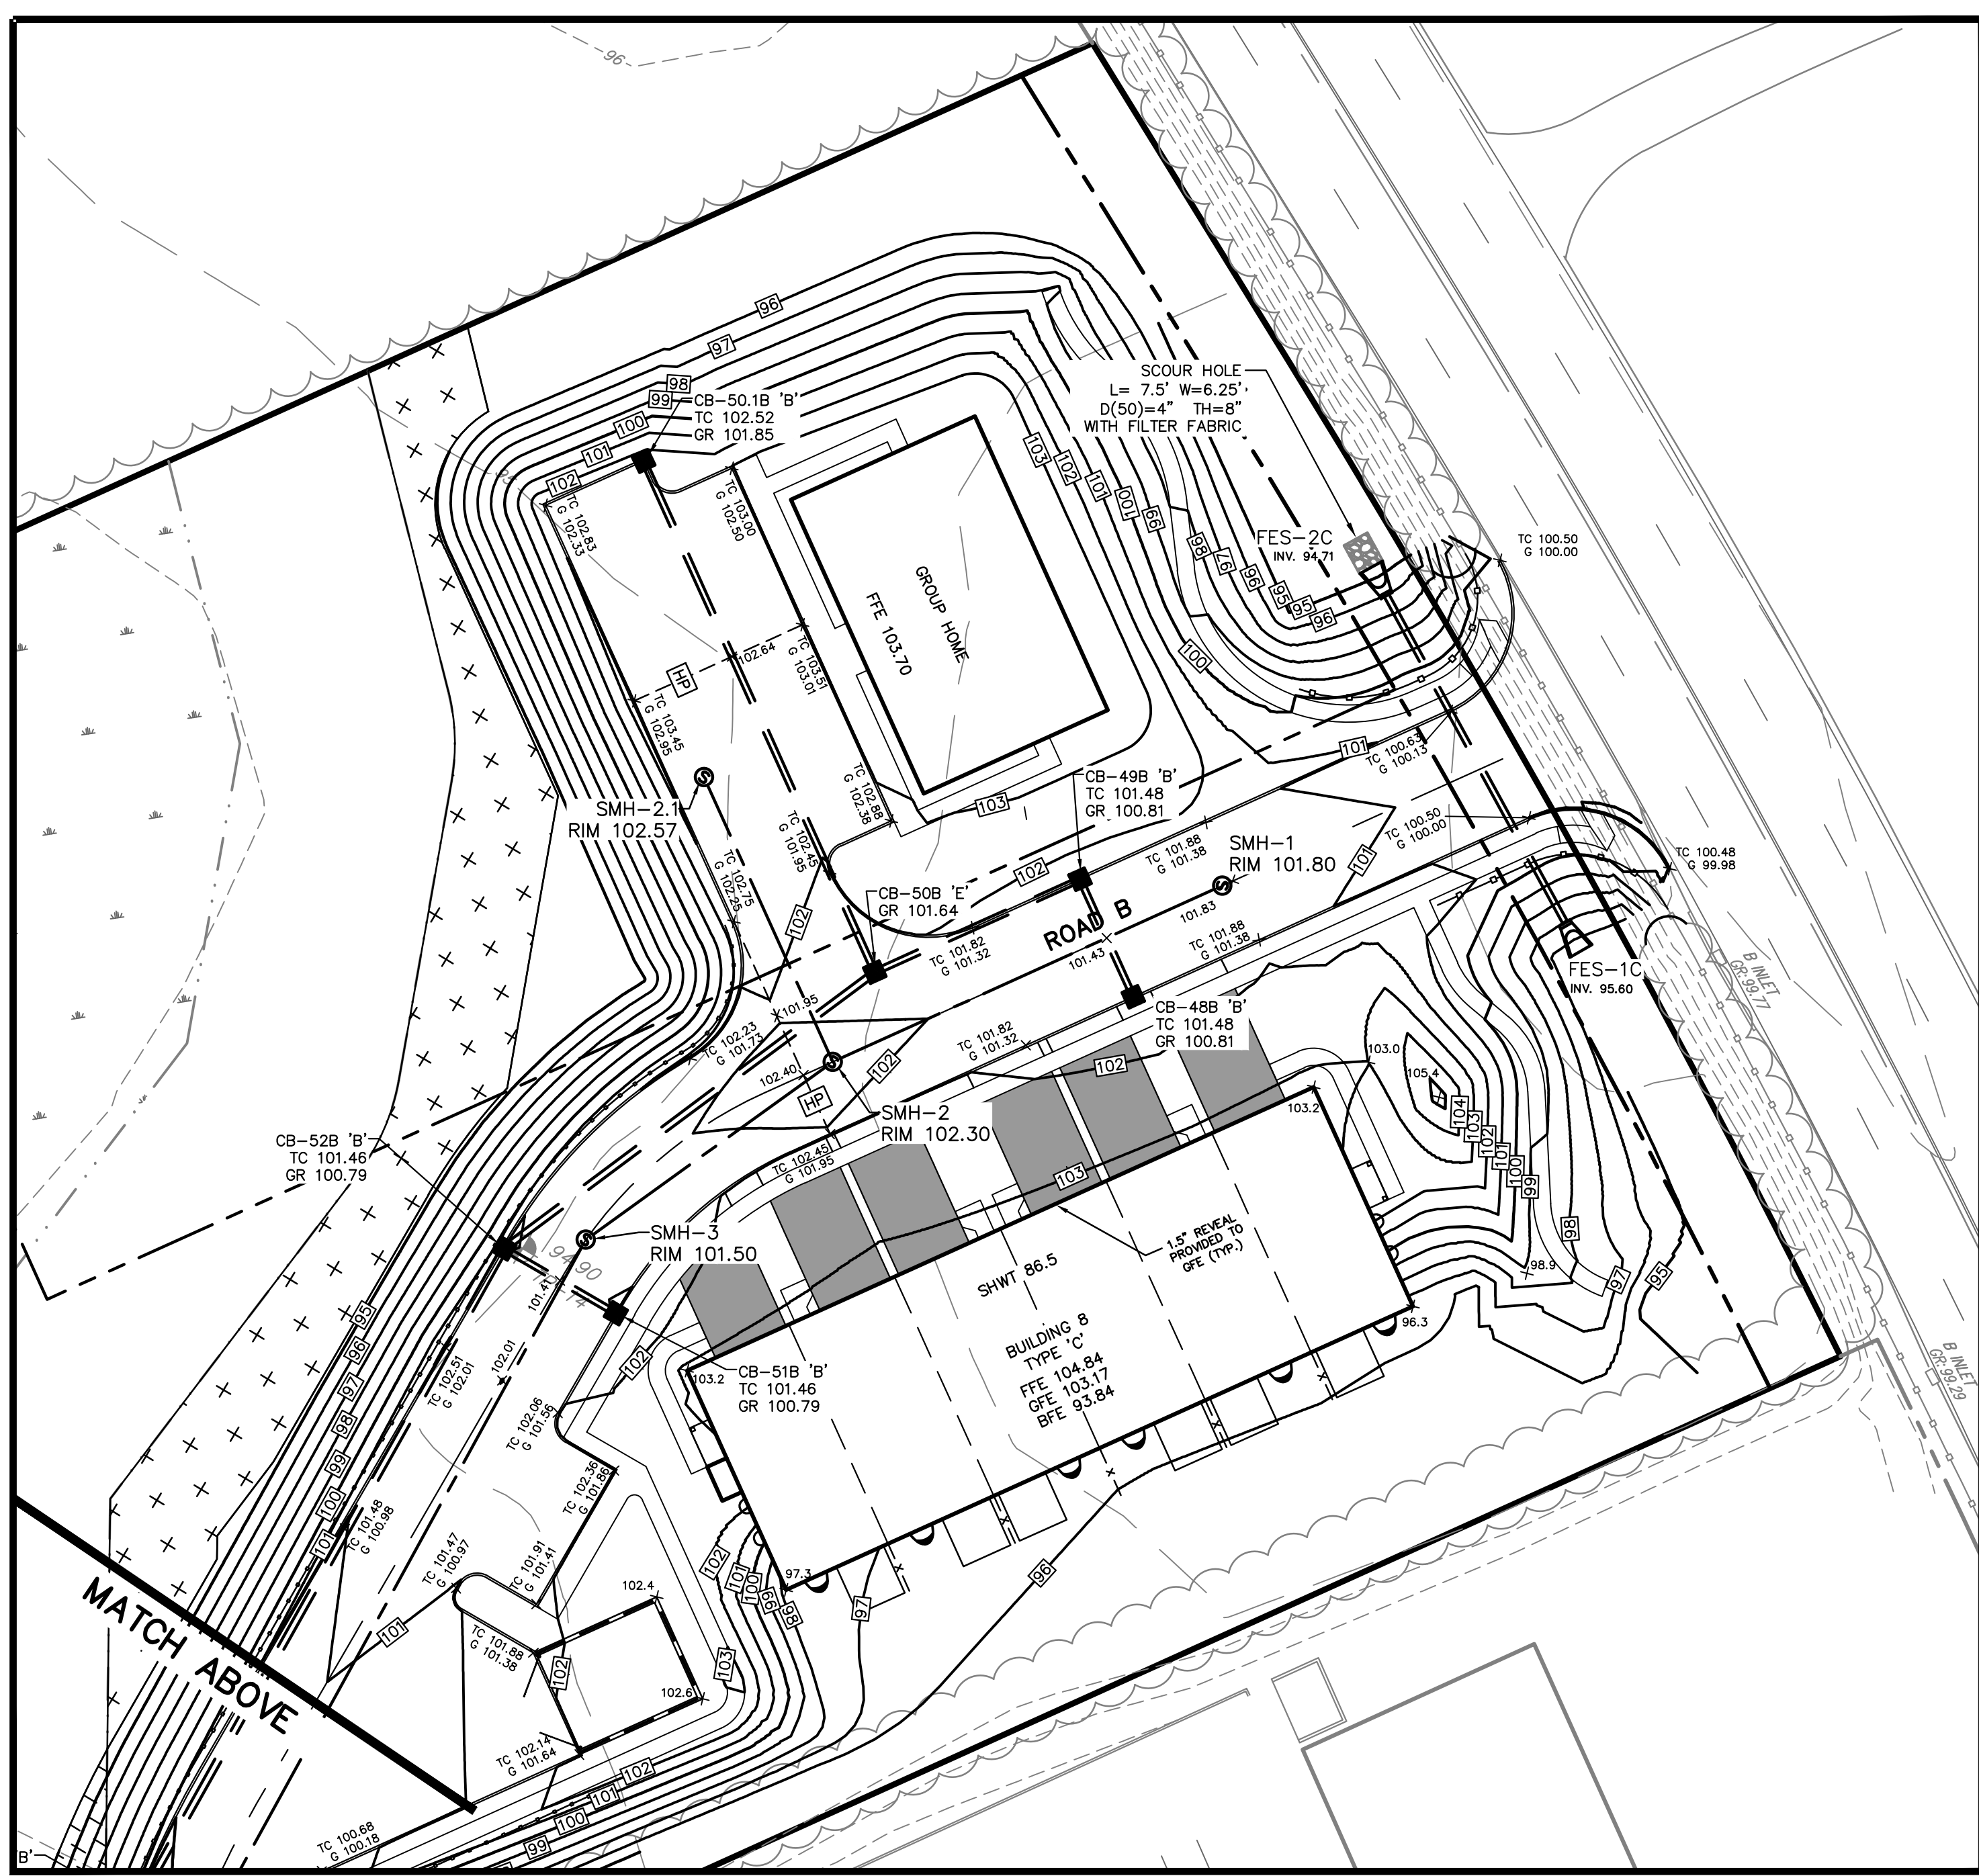
REVISIONS

DATE	BY	REVISIONS
10/02/20	WJV	ADDED GROUP HOME INFO PER CLIENT
03/05/20	WJV	TOWNSHIP REVIEW COMMITTEE COMMENTS
03/05/20	WJV	TOWNSHIP REVIEW COMMITTEE COMMENTS
03/05/20	WJV	TOWNSHIP REVIEW COMMITTEE COMMENTS

RELEASED BY: WJV
 CHECKED BY: WJV
 DATE: 03/05/20
 PROJECT No.: APR-184
 DRAWING NAME: 03-Layout.dwg

VERTICAL SCALE: N/A
 HORIZONTAL SCALE: 1" = 30'

Sheet Number
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LEGEND

- EXISTING CONTOUR
- PROPOSED CONTOUR
- EXISTING SPOT ELEVATION
- PROPOSED SPOT ELEVATION
- EXISTING SANITARY SEWER LINE
- PROPOSED SANITARY SEWER LINE
- EXISTING STORM SEWER LINE
- PROPOSED STORM SEWER LINE
- EXISTING INLET
- PROPOSED INLET
- PROPOSED MANHOLE
- EXISTING SANITARY MANHOLE
- PROPOSED SANITARY MANHOLE
- 100-YR WATER SURFACE ELEV.

GRAPHIC SCALE
1 INCH = 30 FEET

20 0 30 60 90

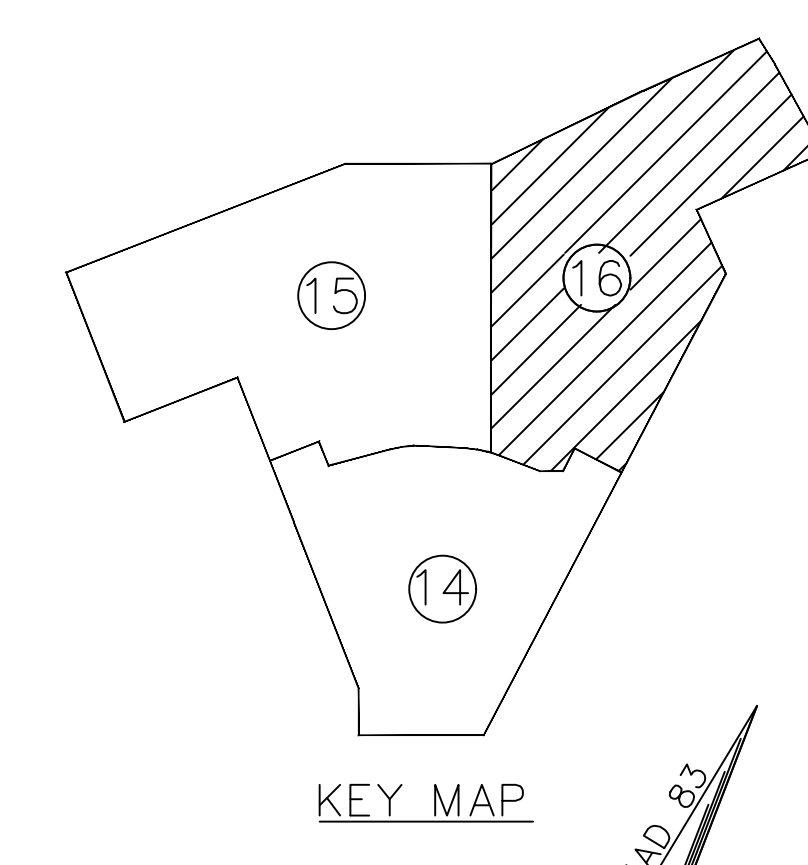
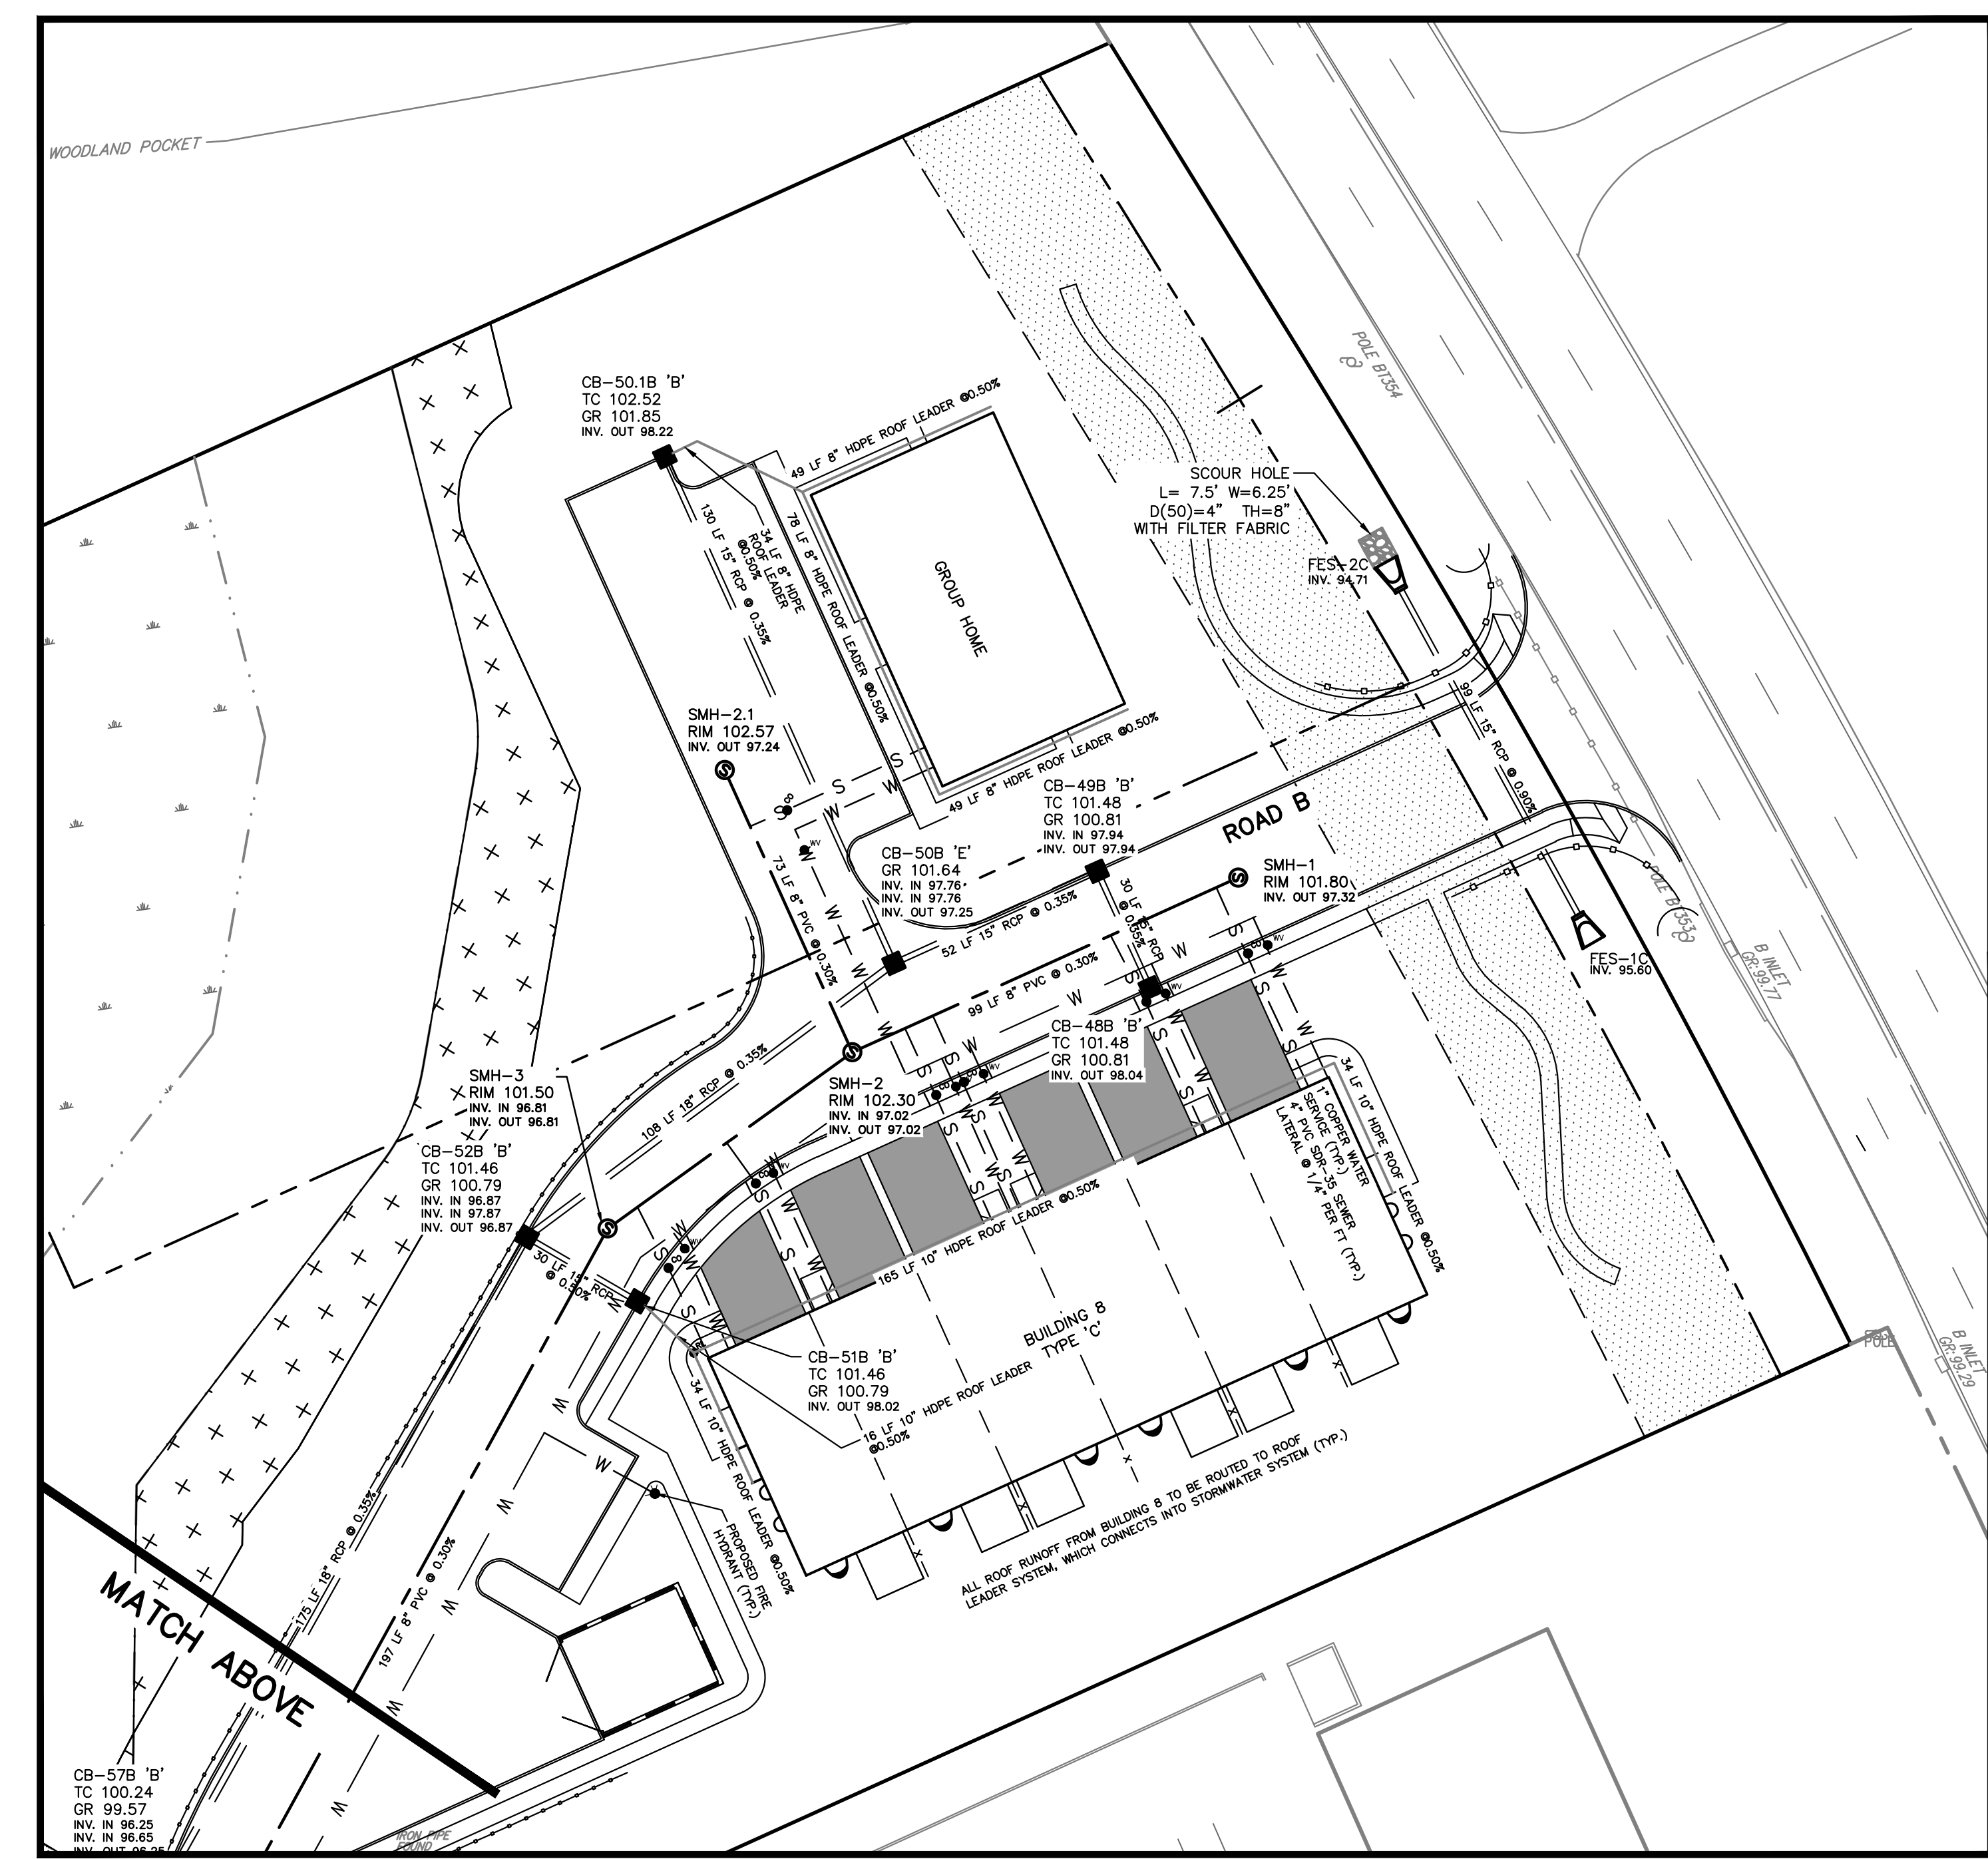
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DATE:	03/05/20	PROJECT NO.:	APR-184	DRAWING NAME:	04-Grading.dwg	REVISIONS:			

PRELIMINARY/FINAL MAJOR SITE PLAN & SUBDIVISION
BLOCK 28, LOTS 15 & 21
HERITAGE AT WEST WINDSOR
GRADING PLAN
SITUATED IN
TOWNSHIP OF WEST WINDSOR, MERCER COUNTY, NEW JERSEY

William J. Parkhill II, P.E.
PROFESSIONAL ENGINEER
No. 142,766, 06/28/2006

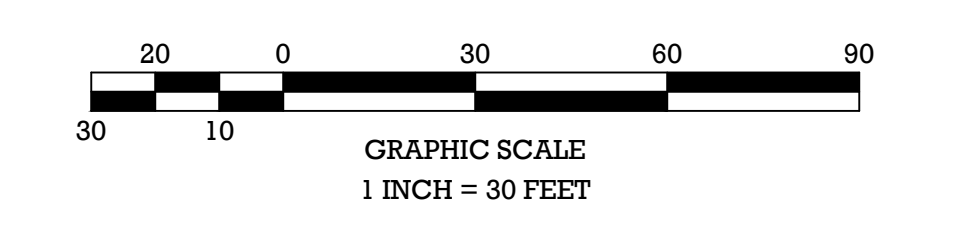
10/02/20

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LEGEND

EXISTING SANITARY SEWER LINE	---
PROPOSED SANITARY SEWER LINE	---
EXISTING STORM SEWER LINE	---
PROPOSED STORM SEWER LINE	---
EXISTING INLET	□
PROPOSED INLET	■
EXISTING MANHOLE	○
PROPOSED SANITARY MANHOLE	●
PROPOSED SANITARY LATERAL	---
PROPOSED SANITARY CLEANOUT	---
EXISTING WATER LINE	---
PROPOSED WATER LINE	---
EXISTING HYDRANT	⊕
PROPOSED WATER HYDRANT	⊕
PROPOSED WATER METER	⊕
PROPOSED WATER LATERAL	---
EXISTING GAS LINE	---
PROPOSED GAS LINE	---



PRELIMINARY/FINAL MAJOR SITE PLAN & SUBDIVISION BLOCK 28, LOTS 15 & 21 HERITAGE AT WEST WINDSOR UTILITY PLAN SITUATED IN TOWNSHIP OF WEST WINDSOR, MERCER COUNTY, NEW JERSEY	CHECKED BY: MWW DATE: 03/05/20	RELEASED BY: MWW DATE: 03/05/20	
	PROJECT NO.: APP-184	VERTICAL SCALE: N/A	DRAWN BY: CE-URBY/04G
	PROJECT NO.: APP-184	HORIZONTAL SCALE: 1"=30' DATE: 03/05/20	REVISIONS: DATE _____ BY _____ REVISIONS _____
	PROJECT NO.: APP-184	PROJECT NO.: APP-184	PROJECT NO.: APP-184
	PROJECT NO.: APP-184	PROJECT NO.: APP-184	PROJECT NO.: APP-184
SHEET NUMBER 16 OF 38	PROJECT NO.: APP-184	PROJECT NO.: APP-184	

William J. Parkhill II, P.E.
 PROFESSIONAL ENGINEER
 No. 34766 (06/25/2006)

MidAtlantic
 ENGINEERING ARCHITECTURE PLANNING
 632 N. 4TH STREET
 ROSELAND, NJ 07068
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PLANT SCHEDULE EASTERN PL BUFFER

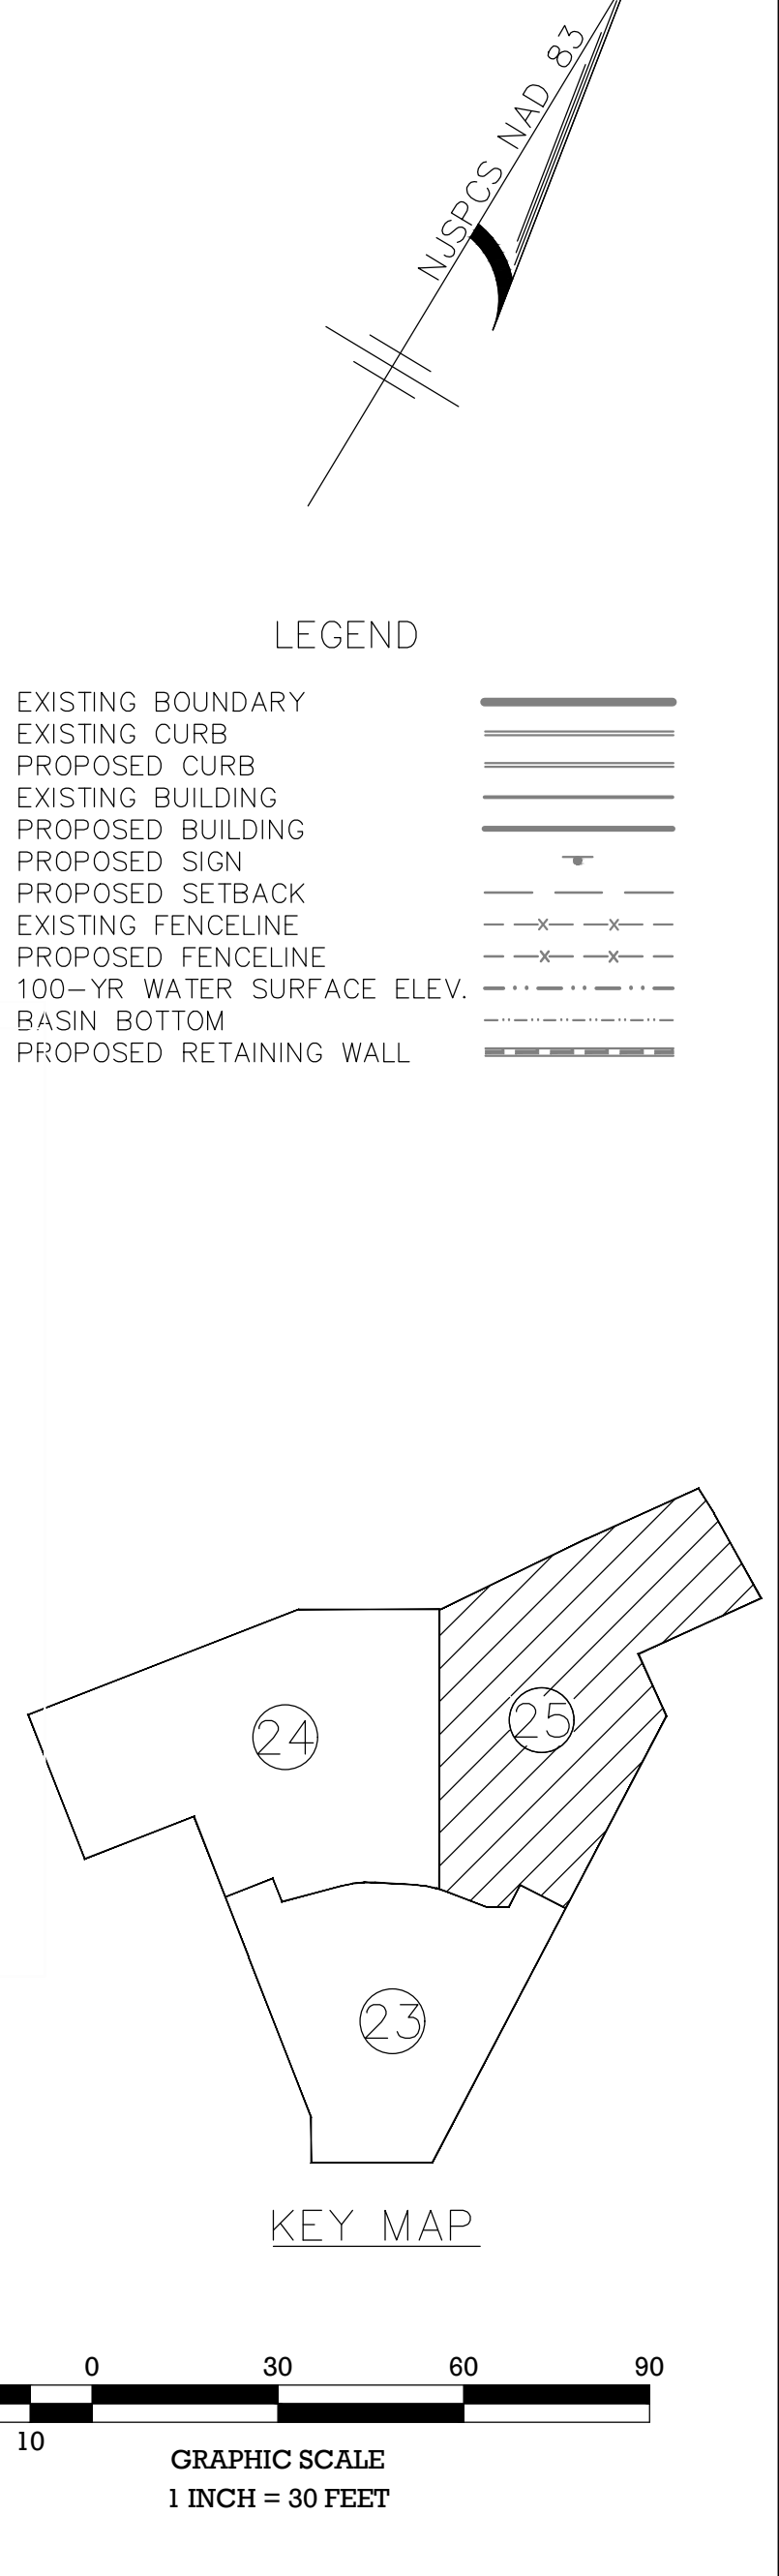
DECIDUOUS SHRUBS	QTY	BOTANICAL NAME	COMMON NAME	SIZE	CONTAINER	REMARKS
CSAF	15	Arctic Fire Red Twig Dogwood	Arctic Fire Red Twig Dogwood	36"	B&B	Drought tolerant plant
MPJ	41	Myrica pensylvanica	Northern Bayberry	3-4' ht.	B&B	
SJAW	6	Spiraea japonica 'Anthony Waterer'	Japanese Spirea	24-30"	B&B	
DECIDUOUS TREES	QTY	BOTANICAL NAME	COMMON NAME	SIZE	CONTAINER	REMARKS
CC	11	Cercis canadensis	Eastern Redbud	21/2-3' cal.	B&B	
CC	5	Ostrya carpinifolia	European Hopbeam	2-21/2' cal.	B&B	
QPH	7	Quercus phellos	Willow Oak	21/2-3' cal.	B&B	
EVERGREEN SHRUBS	QTY	BOTANICAL NAME	COMMON NAME	SIZE	CONTAINER	REMARKS
IMB	13	Ilex x meserriana 'China Boy' TM	China Boy Holly	6-7' HT.	B&B	
IMG	36	Ilex x meserriana 'China Girl' TM	China Girl Holly	6-7' HT.	B&B	Mature ht. of 8-10'
POL	5	Prunus laurocerasus 'Oto Luyken'	Luyken's Laurel	24-30"	B&B	
RCRE	50	Rhododendron catawbiense 'Roseum Elegans'	Catawba Rhododendron	24-30"	B&B	
EVERGREEN TREES	QTY	BOTANICAL NAME	COMMON NAME	SIZE	CONTAINER	REMARKS
IMBM	8	Ilex x meserriana 'Blue Maid' TM	Blue Maid Holly	6-7' HT.	B&B	
JS	19	Juniperus scopulorum 'Wichita Blue'	Wichita Blue Juniper	5-6' HT.	B&B	
PT	12	Pinus thunbergii	Japanese Black Pine	7-8' HT.	B&B	
PM	35	Pseudotsuga menziesii	Douglas Fir	8-10' HT.	B&B	
CL	24	x Cupressocyparis leylandii	Leylandi Cypress	15' HT.	B&B	
FLOWERING SHRUBS	QTY	BOTANICAL NAME	COMMON NAME	SIZE	CONTAINER	REMARKS
VPDF	19	Viburnum plicatum tomentosum	Doublefile Viburnum	24-30"	B&B	
FLOWERING TREES	QTY	BOTANICAL NAME	COMMON NAME	SIZE	CONTAINER	REMARKS
ALS	3	Amelanchier laevis 'Snowcloud'	Snowcloud Allegheny Serviceberry	2-21/2' cal.	B&B	
ORN	5	Cornus florida 'Rainbow'	Rainbow Flowering Dogwood	2-21/2' cal.	B&B	
ORNAMENTAL TREE	QTY	BOTANICAL NAME	COMMON NAME	SIZE	CONTAINER	REMARKS
SJP	3	Sophora japonica 'Pendula'	Japanese Pagoda Tree	2-21/2' cal.	B&B	
STREET TREES	QTY	BOTANICAL NAME	COMMON NAME	SIZE	CONTAINER	REMARKS
AT	4	Acer rubrum 'October Glory' TM	October Glory Maple	3-31/2' cal.	B&B	Mature ht. 40-50'

PLANT SCHEDULE RETENTION BASIN

TREES	QTY	BOTANICAL NAME	COMMON NAME	CONT	CAL	SIZE	REMARKS
FS	6	Prunus x species	Flowering Cherry	6-7' HT.	B&B		
DECIDUOUS TREES	QTY	BOTANICAL NAME	COMMON NAME	CONT	CAL	SIZE	REMARKS
AR5	12	Amelanchier canadensis 'Robin Hill'	Canadian Serviceberry	B & B	2.5' Cal		
BH	16	Betula nigra 'Heritage'	Heritage River Birch	B & B		8'-10' HT.	
NW	15	Nyssa sylvatica 'Wildfire'	Black Gum	B & B	2.5' Cal		
QB	5	Quercus bicolor	Swamp White Oak	21/2-3' cal.	B&B		
EVERGREEN TREES	QTY	BOTANICAL NAME	COMMON NAME	CONT	CAL	SIZE	REMARKS
TON	16	Thuja occidentalis 'Nigra'	Nigra Cedar	6-7' HT.	B&B		
DECIDUOUS SHRUBS	QTY	BOTANICAL NAME	COMMON NAME	CONT	CAL	SIZE	REMARKS
CSAF	21	Cornus sericea	Arctic Fire Red Twig Dogwood	36"	B&B		Drought tolerant plant
EVERGREEN SHRUBS	QTY	BOTANICAL NAME	COMMON NAME	CONT	CAL	SIZE	REMARKS
RCRE	6	Rhododendron catawbiense 'English Roseum'	English Roseum Rhododendron	24-30"	B&B		
FLOWERING SHRUBS	QTY	BOTANICAL NAME	COMMON NAME	CONT	CAL	SIZE	REMARKS
VPDF	35	Viburnum carlesii	Fragrant Viburnum	18-24" HT.	B&B		
ORNAMENTAL TREE	QTY	BOTANICAL NAME	COMMON NAME	CONT	CAL	SIZE	REMARKS
BP	14	Betula papyrifera	Paper Birch	2-21/2' cal.	B&B		
SHRUBS	QTY	BOTANICAL NAME	COMMON NAME	ROOT	SIZE	REMARKS	
IS	64	Ilex verticillata 'Spargelberry'	Wineberry	Cont.	2'-3.5' HT.		
IS	23	Viburnum rhytidophyllum 'Alleghany'	Leatherleaf Viburnum	B & B	3'-4' HT.		

PLANT SCHEDULE GROUP HOME PLANTING

EVERGREEN SHRUBS	QTY	BOTANICAL NAME	COMMON NAME	SIZE	CONTAINER	REMARKS
IGL	10	Ilex cornata 'Green Lustre'	Green Lustre Japanese Holly	18-24" HT.	B&B	
KLOF	6	Kalmia latifolia 'Olympic Fire'	Mountain Laurel	3-4' HT.	B&B	
EVERGREEN TREES	QTY	BOTANICAL NAME	COMMON NAME	SIZE	CONTAINER	REMARKS
JCSF	8	Juniperus chinensis 'Spartan'	Spartan Juniper	7-8' HT.	B&B	narrow grower 4-5' wide
FLOWERING SHRUBS	QTY	BOTANICAL NAME	COMMON NAME	SIZE	CONTAINER	REMARKS
AD	6	Azalea x 'Delaware Valley White'	Valley White Azalea	18-24" HT.	B&B	Mature ht. of 6'
HMTS	6	Hydrangea macrophylla 'Twist-n-Shout'	Twist-n-Shout Hydrangea	18-24" HT.	B&B	
VC	3	Viburnum carlesii	Fragrant Viburnum	18-24" HT.	B&B	
DECIDUOUS SHRUBS	QTY	BOTANICAL NAME	COMMON NAME	SIZE	CONTAINER	REMARKS
CSAF	6	Cornus sericea	Arctic Fire Red Twig Dogwood	18-24" HT.	B&B	Drought tolerant plant
DECIDUOUS TREES	QTY	BOTANICAL NAME	COMMON NAME	SIZE	CONTAINER	REMARKS
CC	4	Cercis canadensis	Eastern Redbud	2-21/2' cal.	B&B	



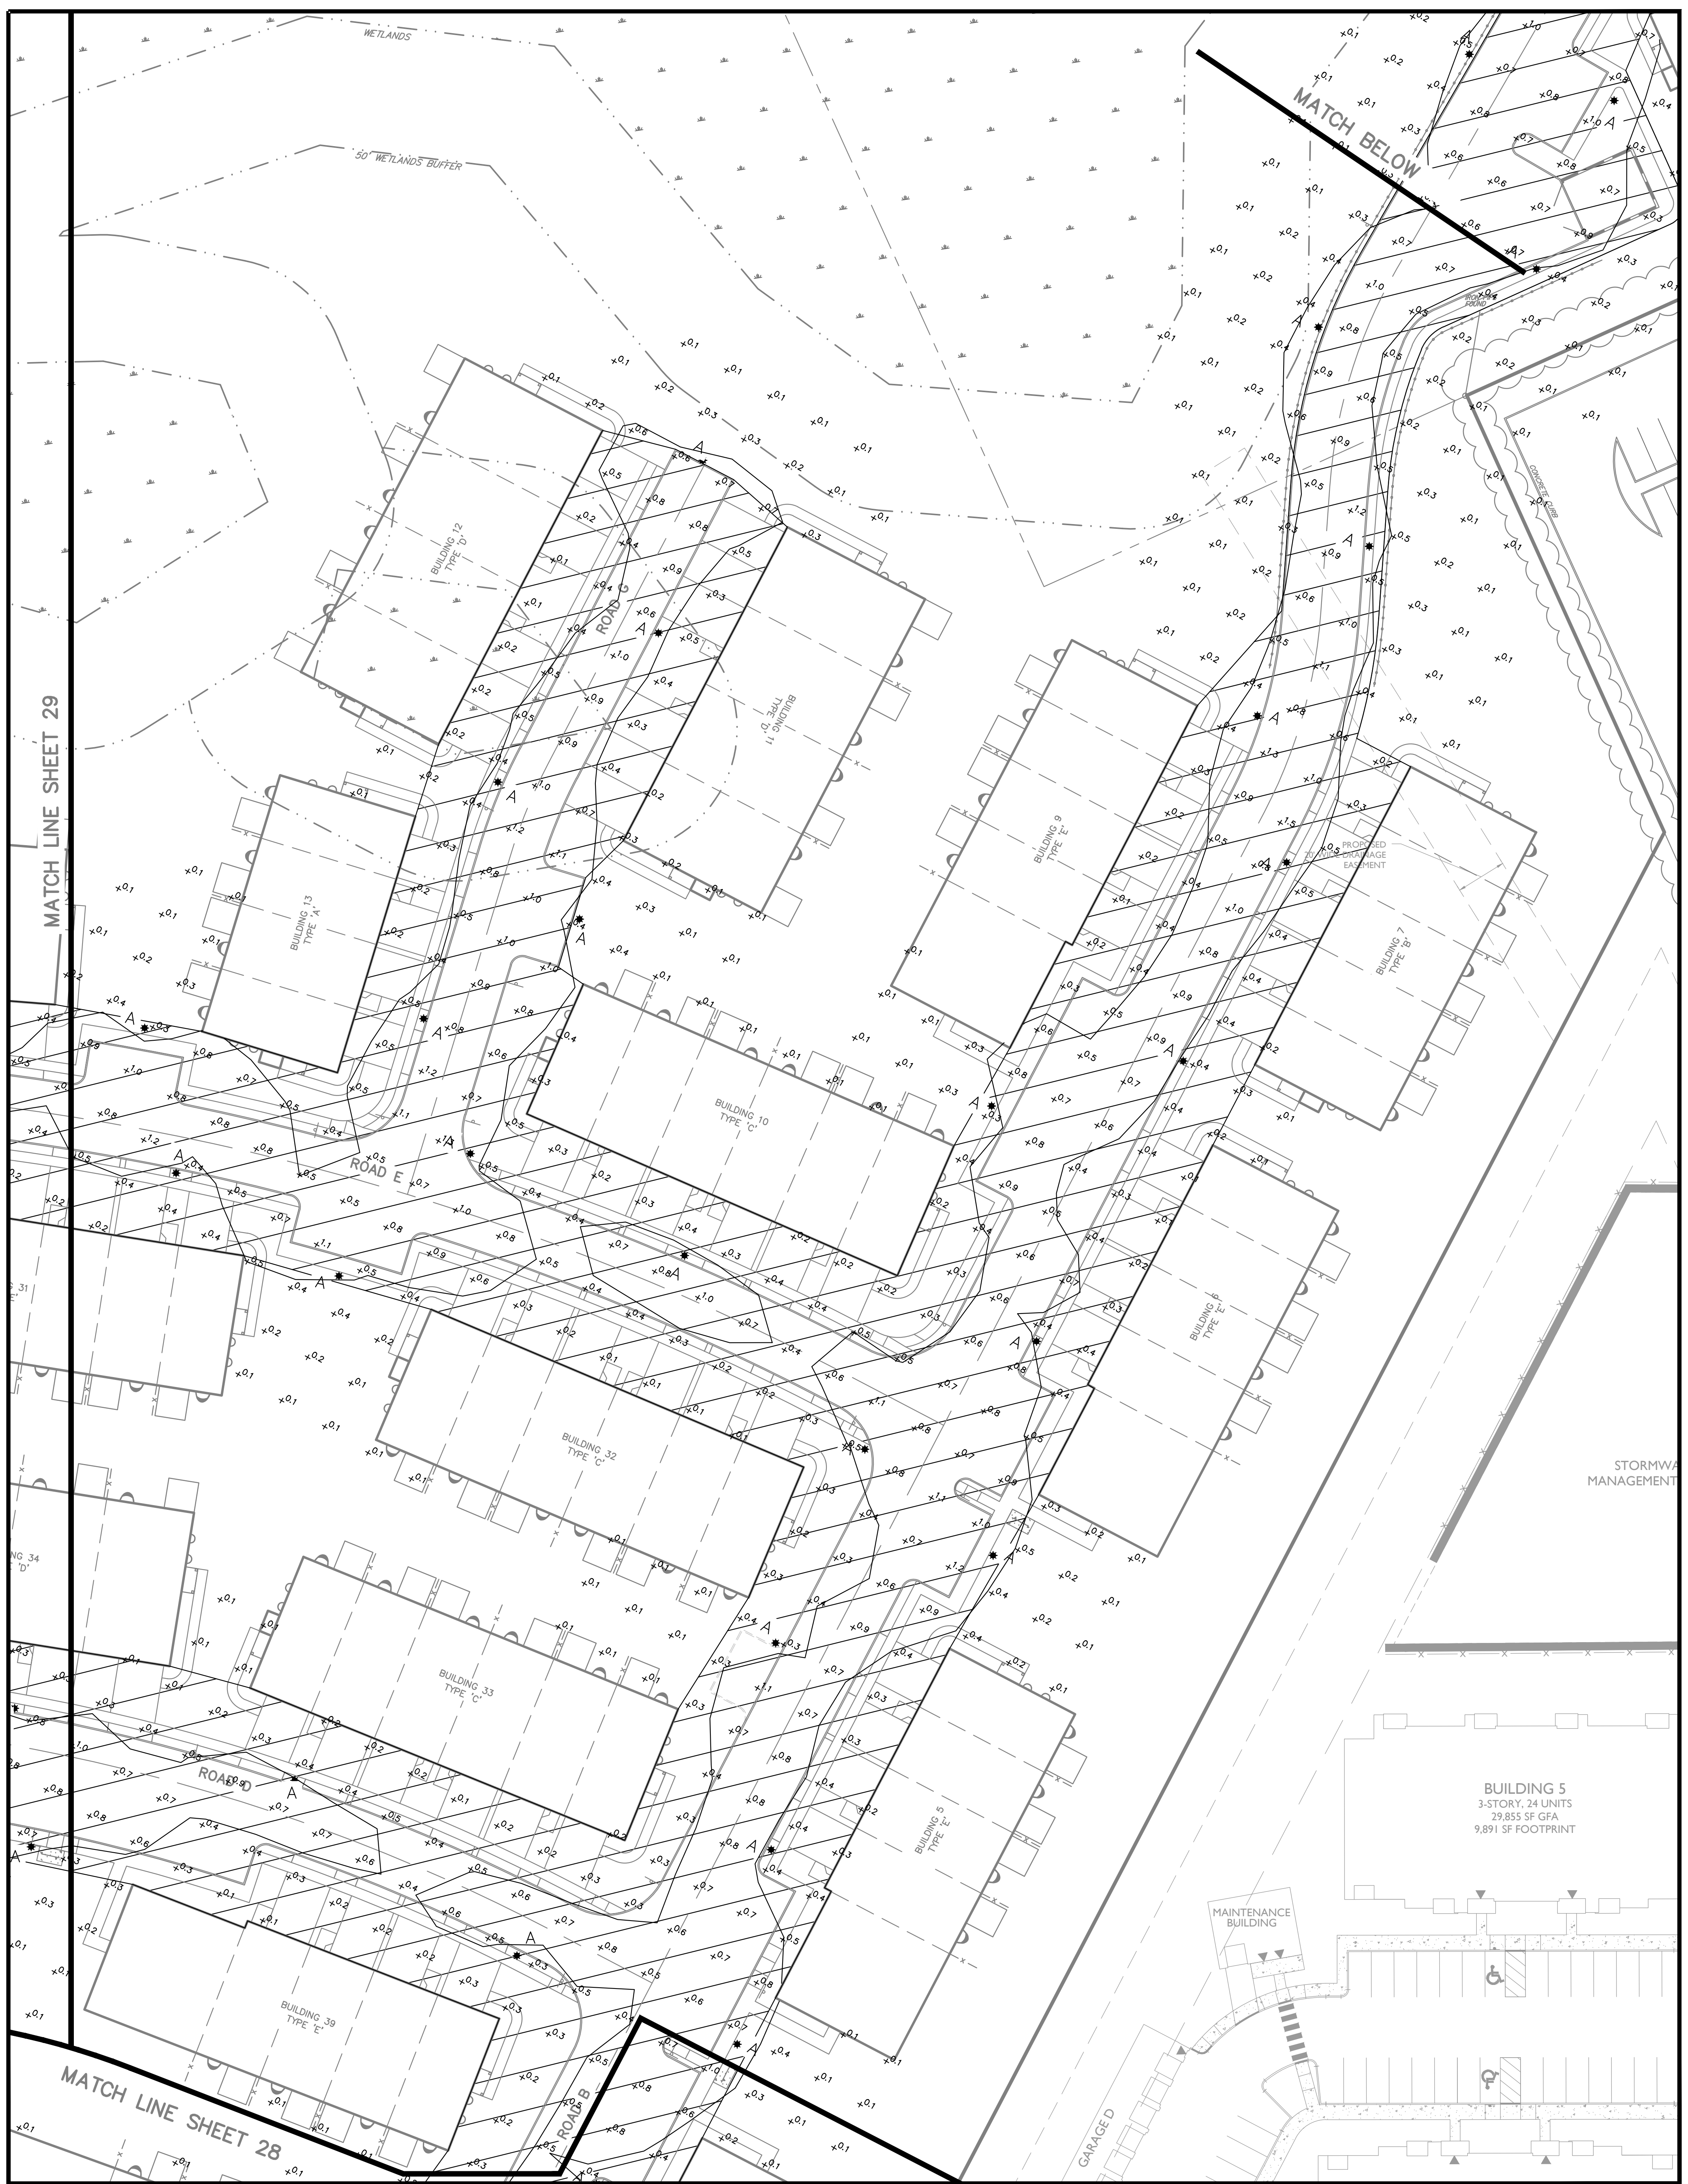
PRELIMINARY/FINAL MAJOR SITE PLAN & SUBDIVISION
BLOCK 28, LOTS 15 & 21
HERITAGE AT WEST WINDSOR
LANDSCAPE PLAN

DATE: 10/02/20
DRAWN BY: Peggy L. Steinhilber
CHECKED BY: MWW
DATE: 03/05/20
PROJECT No.: APR-184
DRAWING NAME: 06-Landscape.dwg
TOWNSHIP OF WEST WINDSOR, MERCER COUNTY, NEW JERSEY
SITUATED IN

Sheet Number
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PE No. 06A0046500
PE No. 06A0056500
PE No. 06A0066500

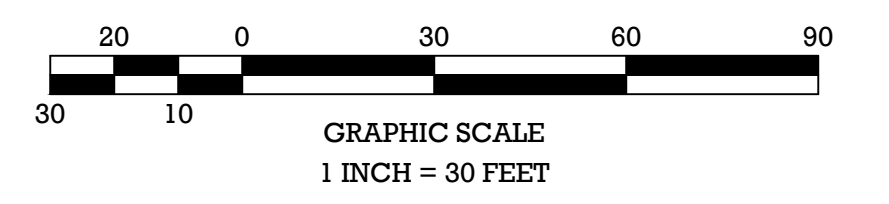
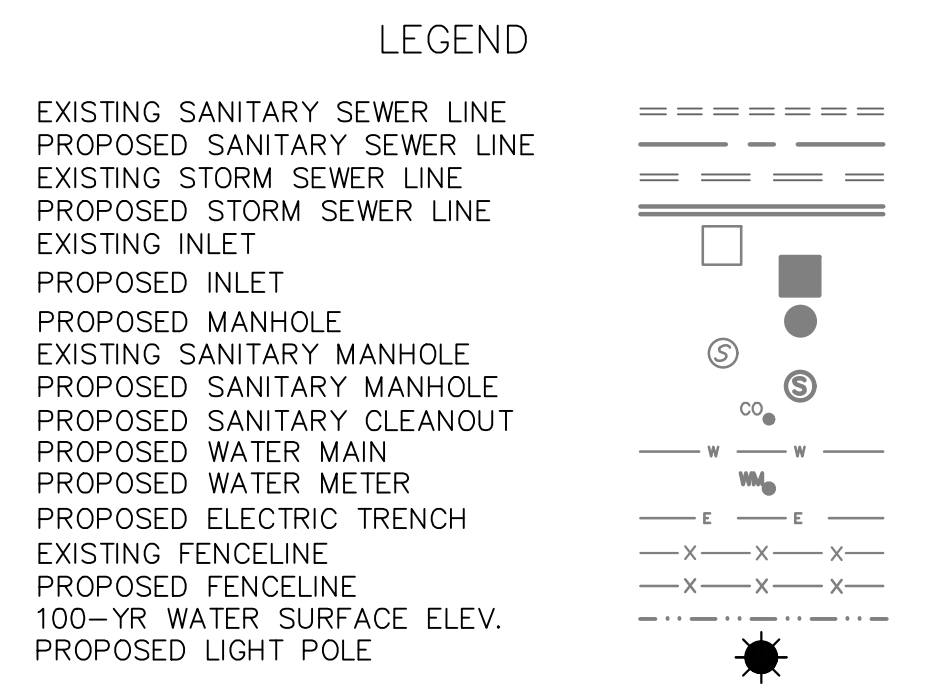
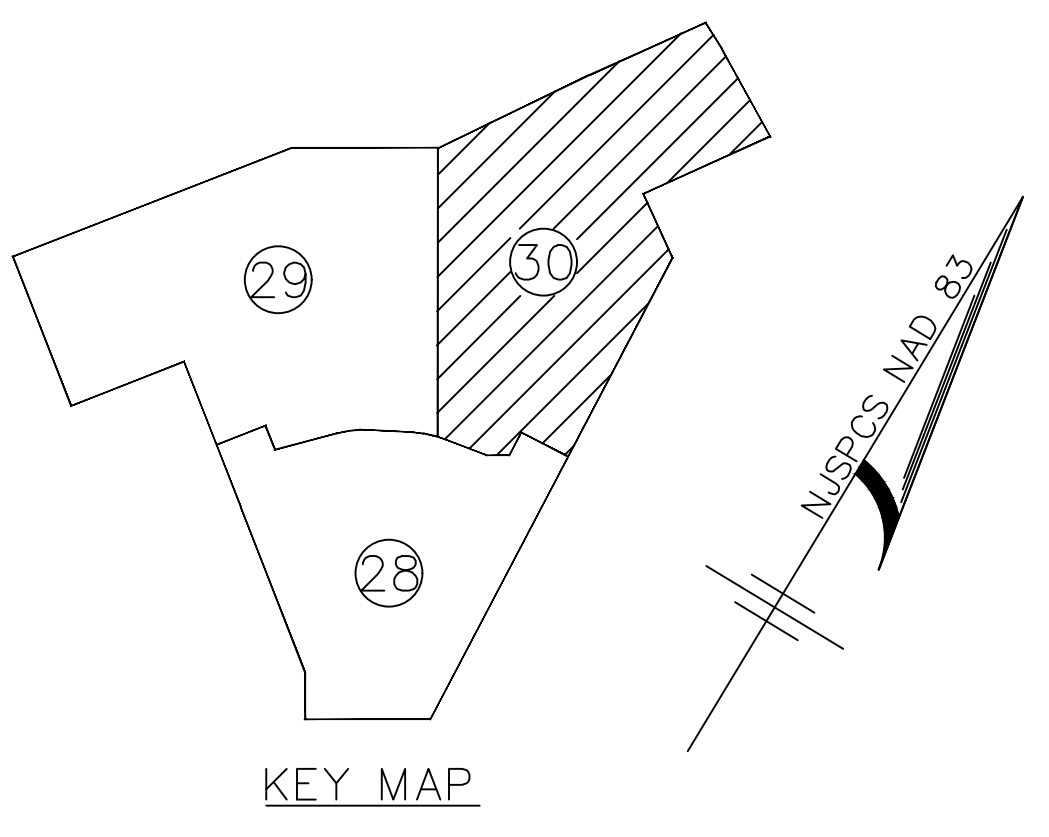
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 Plot Time: 05/01/2020 - 4:15pm



Symbol	Label	Quantity	Manufacturer	Catalog Number	Description	Lamp	Number Lamps	Lumens Per Lamp	Light Loss Factor	Wattage
	A	112	Holophane	GVD2 P20 30K AS 3 N F	Granville II LED, LED Package 20, 39W, 3000K, 120-277V, Type 3 distribution, No trim with Full Cover option	LED COB	1	4644	1	39
	B	10	Holophane	GVD2 P40 30K AS 3 N	Granville II LED, LED Package 40, 91W, 3000K, 120-277V, Type 3 distribution, No trim	LED COB	1	8647	1	81

LIGHTING INTENSITY
 Calc Zone Residential
 Average 0.6 fc
 Old Trenton intersection
 Average 3.4 fc
 Hightstown intersection
 Average 3.0 fc
 LIGHTING DESIGNED REFERENCING ORDINANCE 200-31
 CALCULATION ZONE ENCOMPASSES RESIDENTIAL AREAS

- Lighting Notes**
- The proposed light fixtures shall be installed at the mounting height indicated on the light pole / fixture detail.
 - Light fixture poles shall be set at least 3 ft. behind the face of curb unless otherwise noted.
 - Light pole footings shall have a maximum 6" concrete exposed above grade, except in locations specifically shown & designed with 3'-0" exposed concrete to protect fixtures from vehicular traffic.
 - Exterior site lights shall operate based on a programmed and managed schedule by owner utilizing timers and/or photo sensors. Lighting shall be used to address site specific needs and safety requirements. Full "plan" intensity shall be provided for high use times such as 1/2 hour before sunrise to 1/2 past business closure or until 11 PM for residential uses; and, 1/2 hour before business opens or 6 am until 1/2 past sunrise. Wherever possible, overnight lighting shall be reduced to appropriate minimums, by either entirely turning off individual fixtures or reducing fixture output to a 50% or lower percentage of max.
 - Cut-off shields, house side shields, and similar anti glare measures shall be provided to the maximum extent.



PRELIMINARY/FINAL MAJOR SITE PLAN & SUBDIVISION
 BLOCK 28, LOTS 15 & 21
 HERITAGE AT WEST WINDSOR
 LIGHTING PLAN
 SITUATED IN
 TOWNSHIP OF WEST WINDSOR, MERCER COUNTY, NEW JERSEY

Checked By: MWW
 Date: 03/05/20
 Project No.: APR-184
 Drawing Name: 07-Lighting.dwg

Released By: MWW
 Vertical Scale: N/A
 Horizontal Scale: 1"=30'

10/02/20 ADDED GROUP HOME INFO PER CLIENT
 8/21/20 TOWNSHIP REVIEW COMMITTEE COMMENTS
 7/10/20 TOWNSHIP REVIEW COMMITTEE COMMENTS

DATE: 10/02/20
 DRAWN BY: [Signature]
 PROJECT ENGINEER: William J. Parkhill II, P.E.
 PROFESSIONAL ENGINEER
 No. 06176600000000

Sheet Number
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